

NOTES:

- ALL COMMS CABLING SHALL BE RUN IN PVC CONDUIT IN WALL CAVITY BETWEEN OUTLETS AND CEILING SPACE (FOR FUTURE RE-WIRING)
- FOR ALL ACCESS WC FACILITIES, GENERAL PURPOSE OUTLETS SHALL BE LOCATED NOT LESS THAN 600mm NOR MORE THAN 1100mm ABOVE THE FINISHED FLOOR LEVEL AND NOT LESS THAN 500mm FROM INTERNAL CORNERS.

DRAWING LIST	
Drawing #	Description
E01	BASEMENT AND GROUND FLOORS - POWER AND COMMS LAYOUT
E02	FIRST AND SECOND-THIRD FLOORS - POWER AND COMMS LAYOUT
E03	ROOF PLAN - POWER LAYOUT
E04	BASEMENT AND GROUND FLOORS - LIGHTING LAYOUT
E05	FIRST AND SECOND-THIRD FLOORS - LIGHTING LAYOUT
E06	POWER DETAILS
E07	LIGHTING DETAILS
E08	LEGEND
E09	SINGLE LINE DIAGRAM
E10	SEISMIC DETAILS

PROVIDE COMMON TRENCH BETWEEN UNDERGROUND POWER AND COMMS SERVICES WHERE POSSIBLE

DRAWINGS TO BE READ IN CONJUNCTION WITH ELECTRICAL SPECIFICATION

REFER TO CIVIL SPECIFICATION FOR TRENCHING, COMPACTING, BACKFILLING AND SURFACE RE-INSTALLMENT REQUIREMENTS

A	21-11-18	REVISED AS SHOWN CLOUDED	PTK
-	27-08-18	TENDER ADDENDUM	PTK
Rev	Date	Issue Description	By

Project
PROPOSED COMMERCIAL DEVELOPMENT
97 KING WILLIAM STREET
KENT TOWN

Title
ELECTRICAL SERVICES
BASEMENT AND GROUND FLOORS -
POWER AND COMMS LAYOUT


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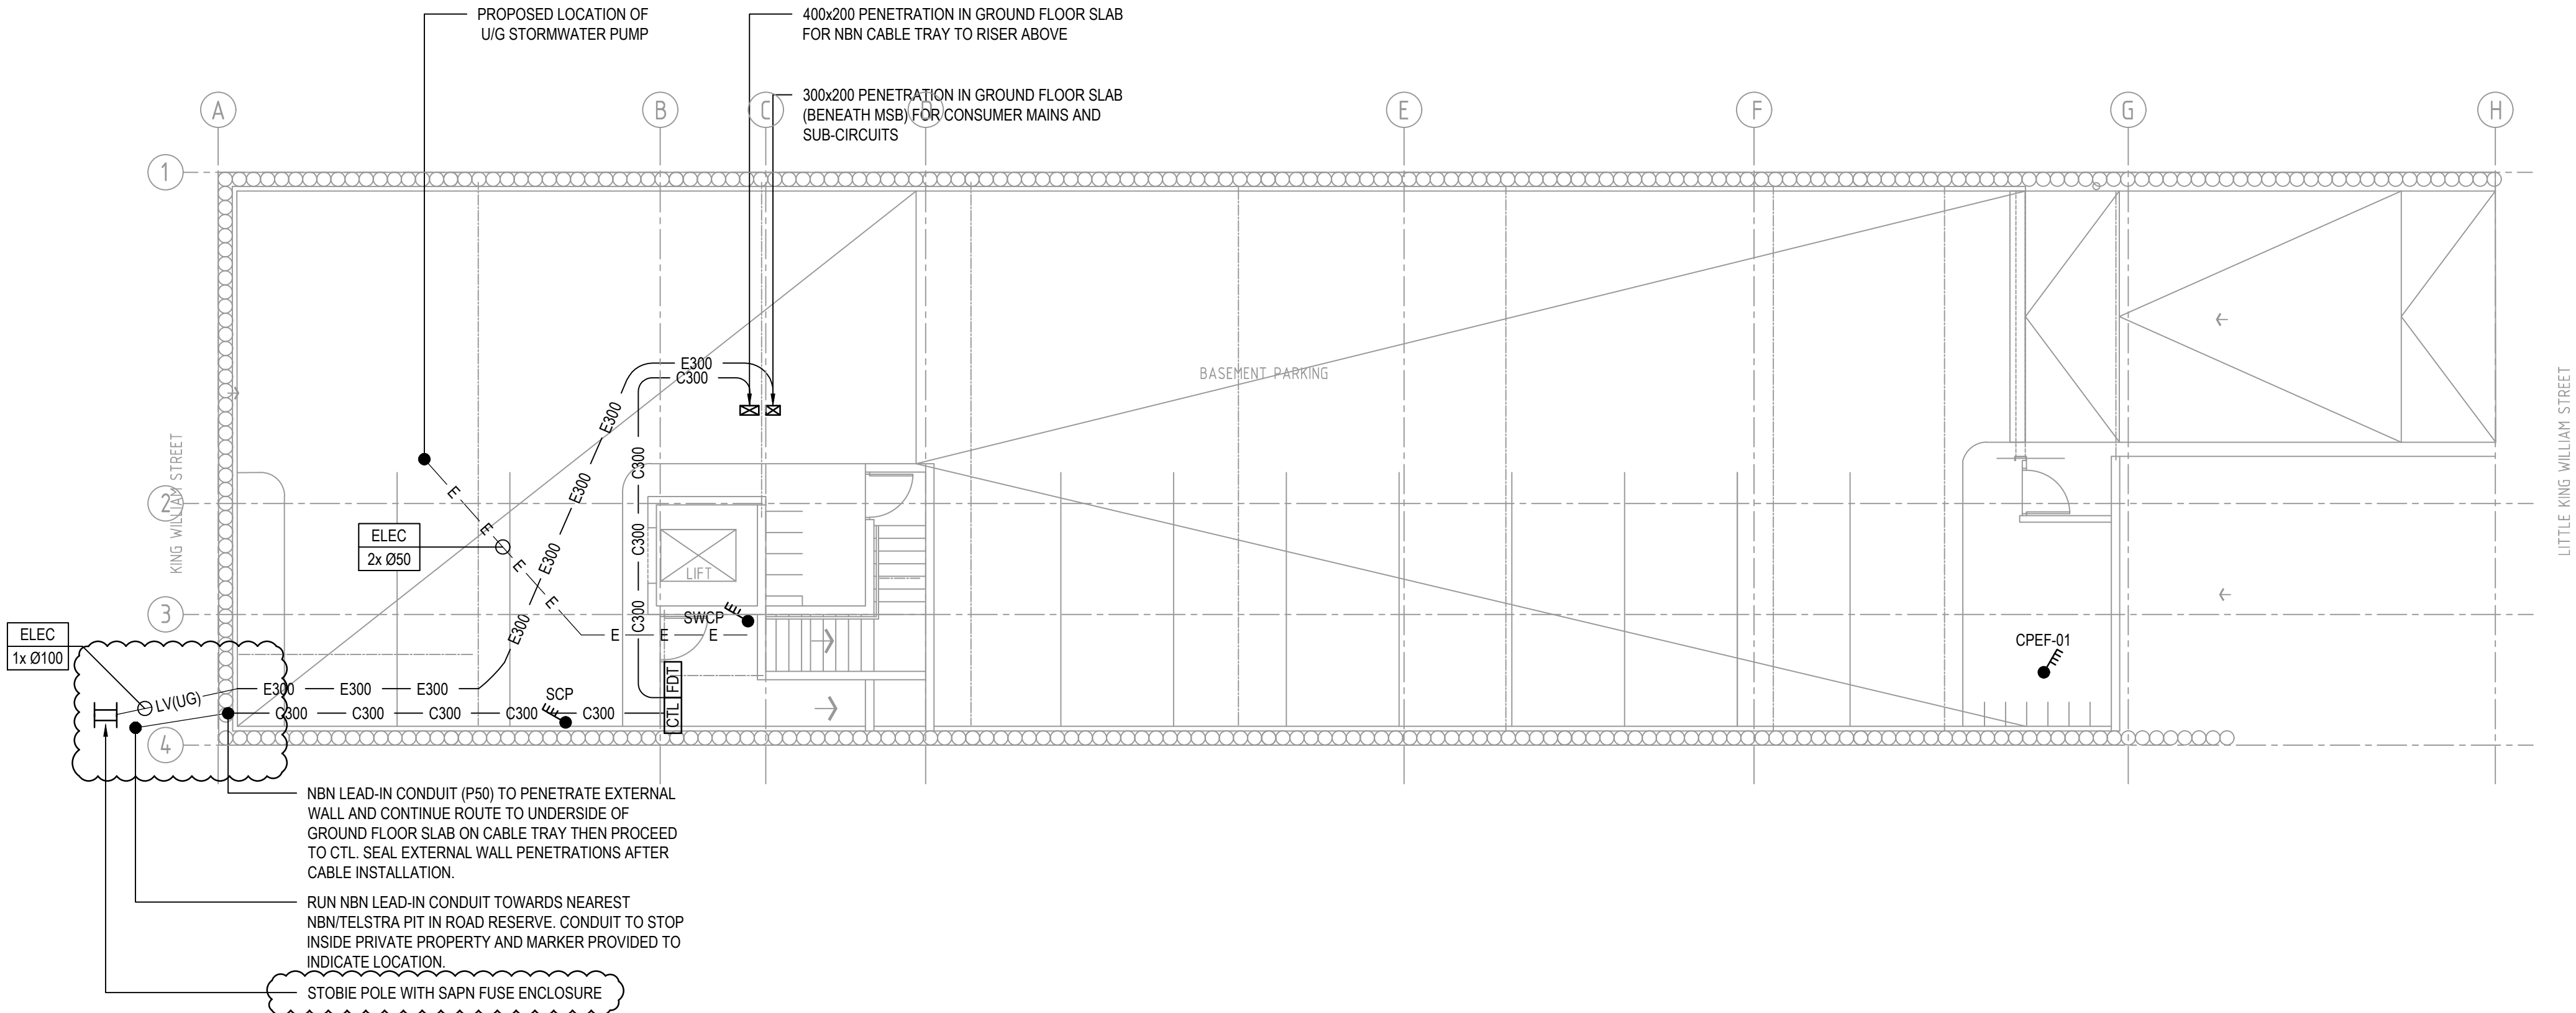
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	ENG	RB	Q.A.
	DATE	MAR '18	SCALE
			1:100 @ A1
DRAWING No.		B8014-E01	
PLOT DATE:	21/11/2018	Size:	Rev.
		A1	A

GROUND FLOOR PLAN
SCALE 1:100



BASEMENT PLAN
SCALE 1:100

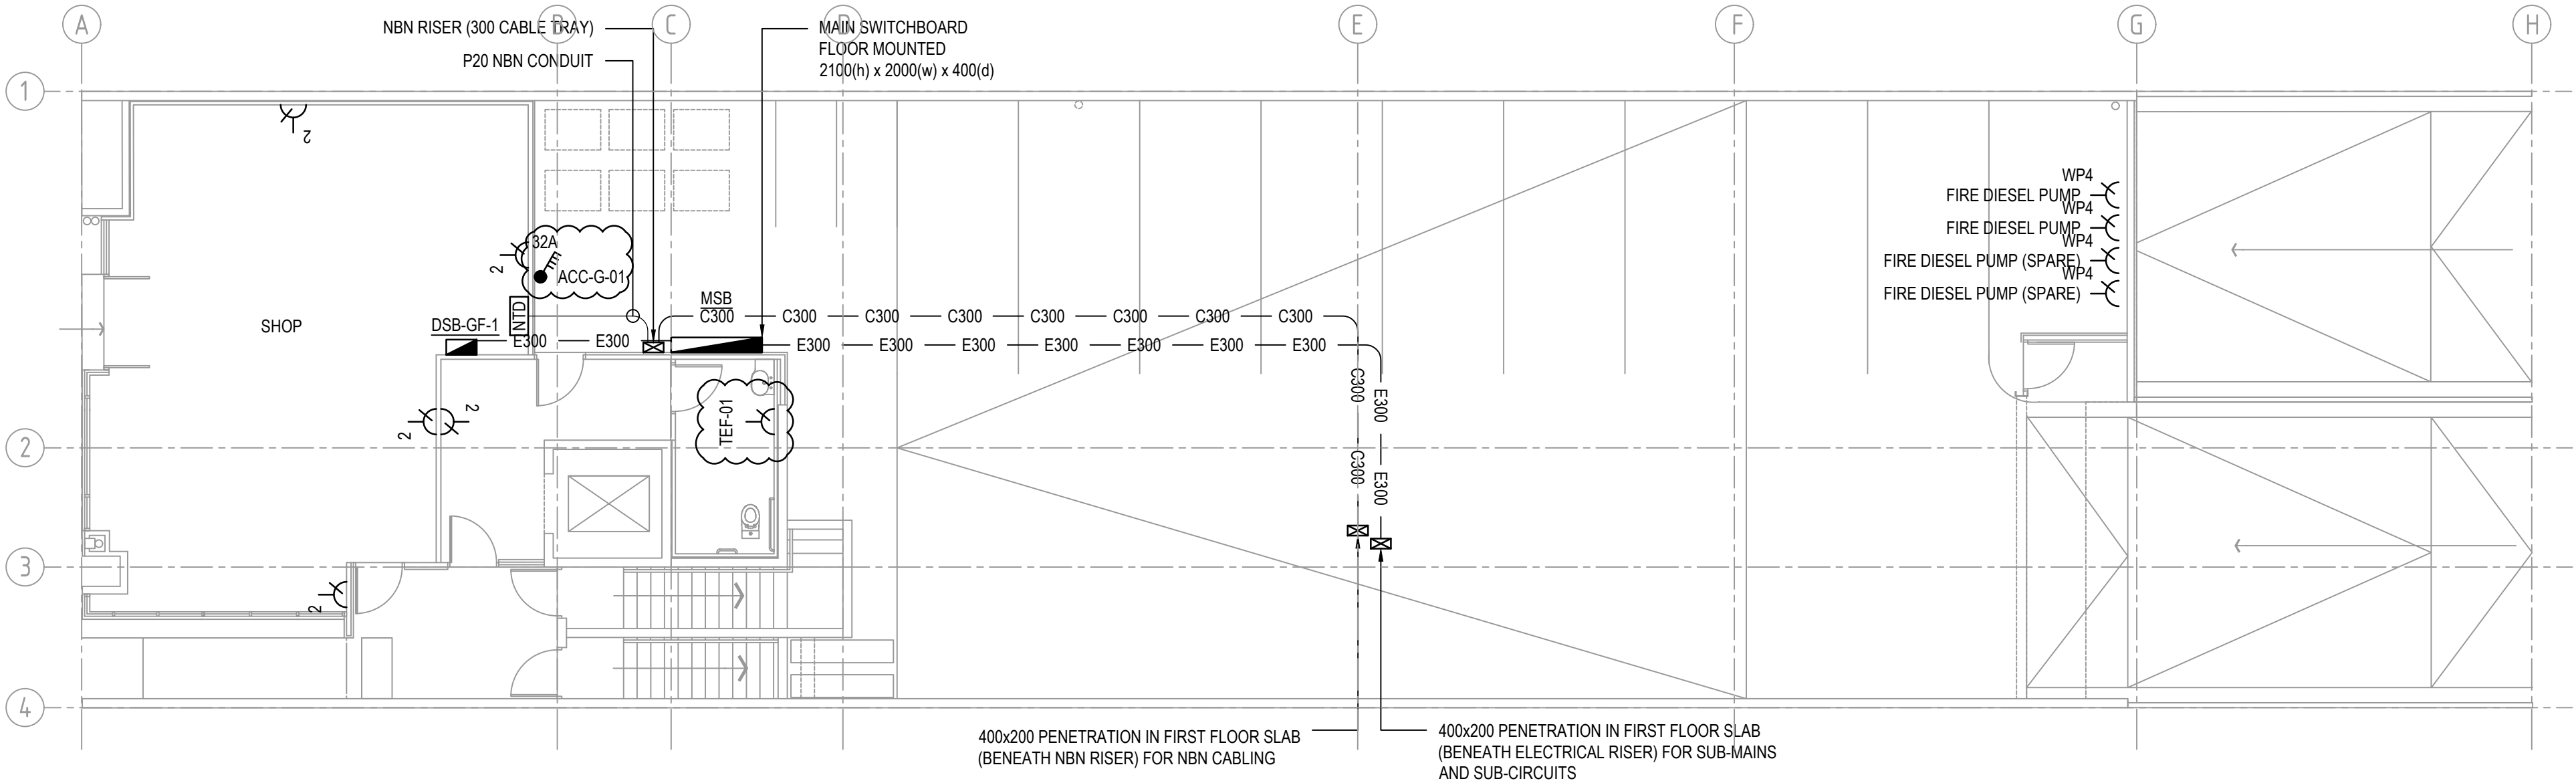

TENDER